General


Do not scale from this drawing. All dimensions to be checked on site by contractor prior to commencement of proposed works.


Before commencement of any work full building control and planning approval must be obtained. This drawing to be read in conjuction with all other drawings 40-CC/01-06. No responsibility for building works can be taken by the agent since no inspections will take place during construction. All dimensions to be checked by contractor prior to commencement of the works. All workmanship and materials to be in accordance with current Building Regulations, British Standard, Code of Practice or Agreement Certificae and fixed, applied or mixed in accordance with manufacturers installation instructions. All services installations and work shall comply with the regulations and recommendations of the respective statutory undertaking or authority to the satisfaction of the relevant inspector. This drawing has been prepared for the purpose of applying for town and country planning and building regulations approvals only, its use for any other purpose is to be done with discretion.




Site Location Plan (Scale 1:1250)

PROJECT:	Proposed Rear Extension 40 Chestnut Close, Hockley, Essex, SS5 5EQ.		DRAWING TITLE: Site Location Plan
CLIENT:	Mr & Mrs Robinson		
SCALE: DATE:	1:1250 Sept 2008	DRAWN BY: DRAWING: 40-CC/01	

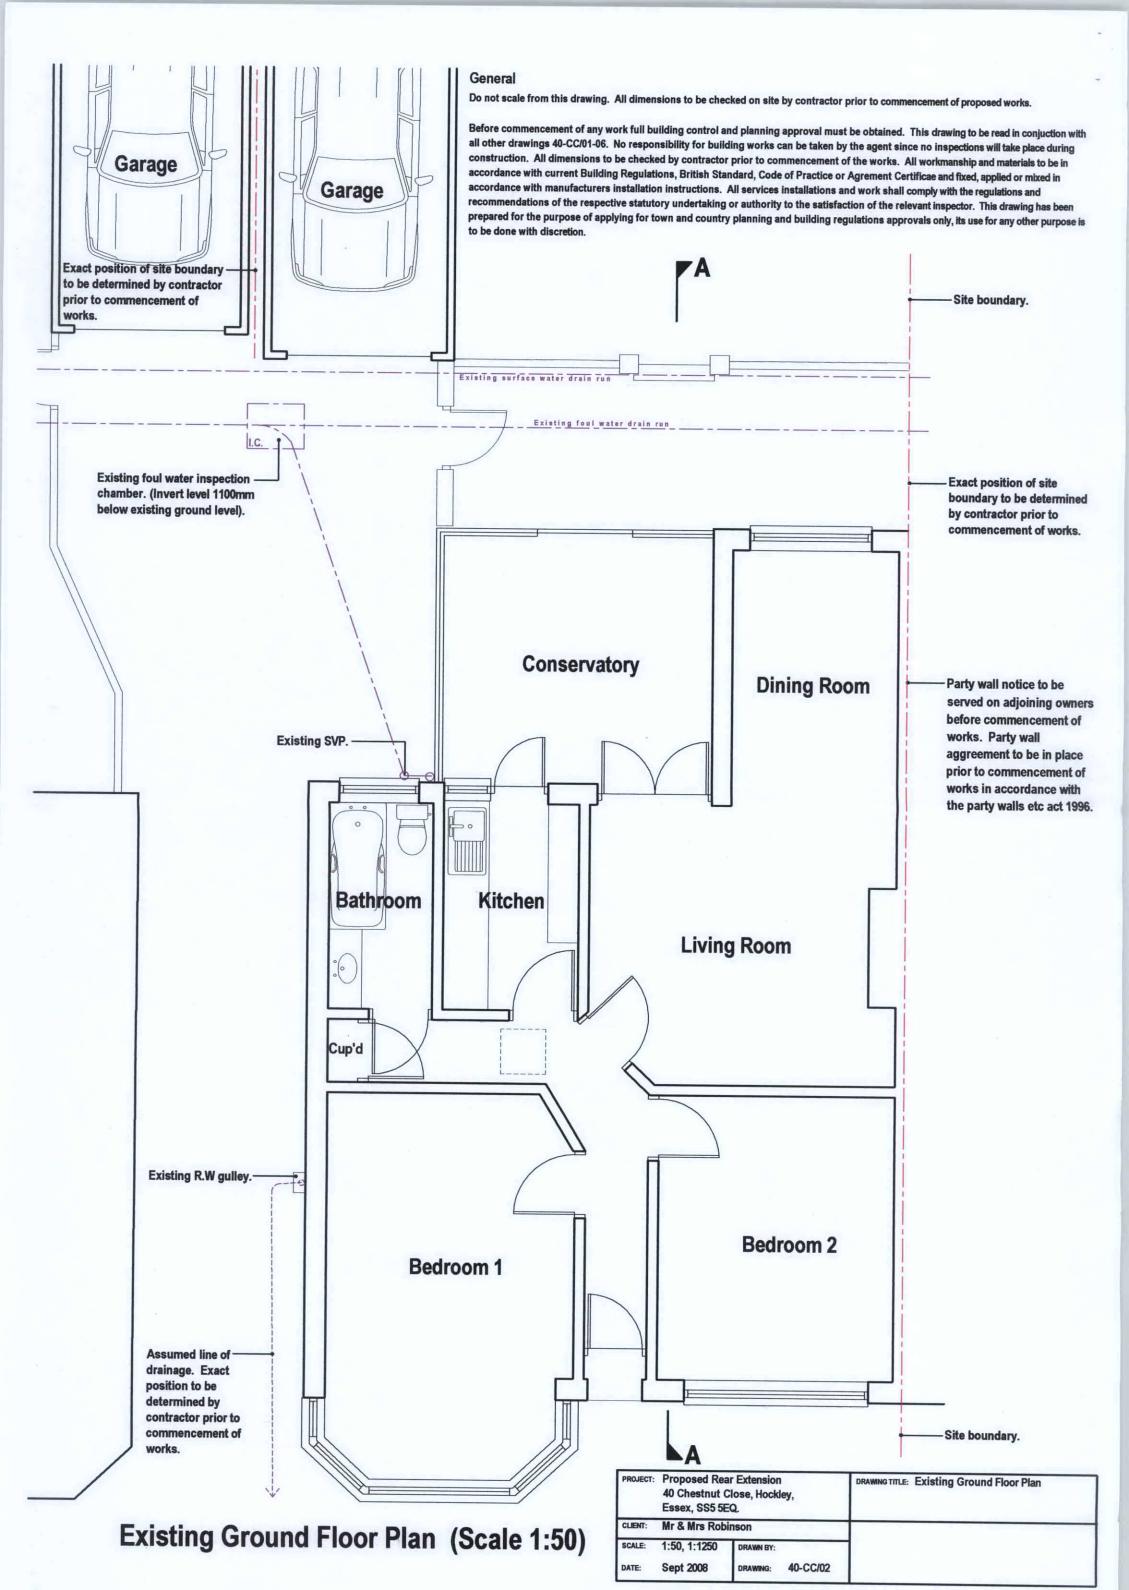

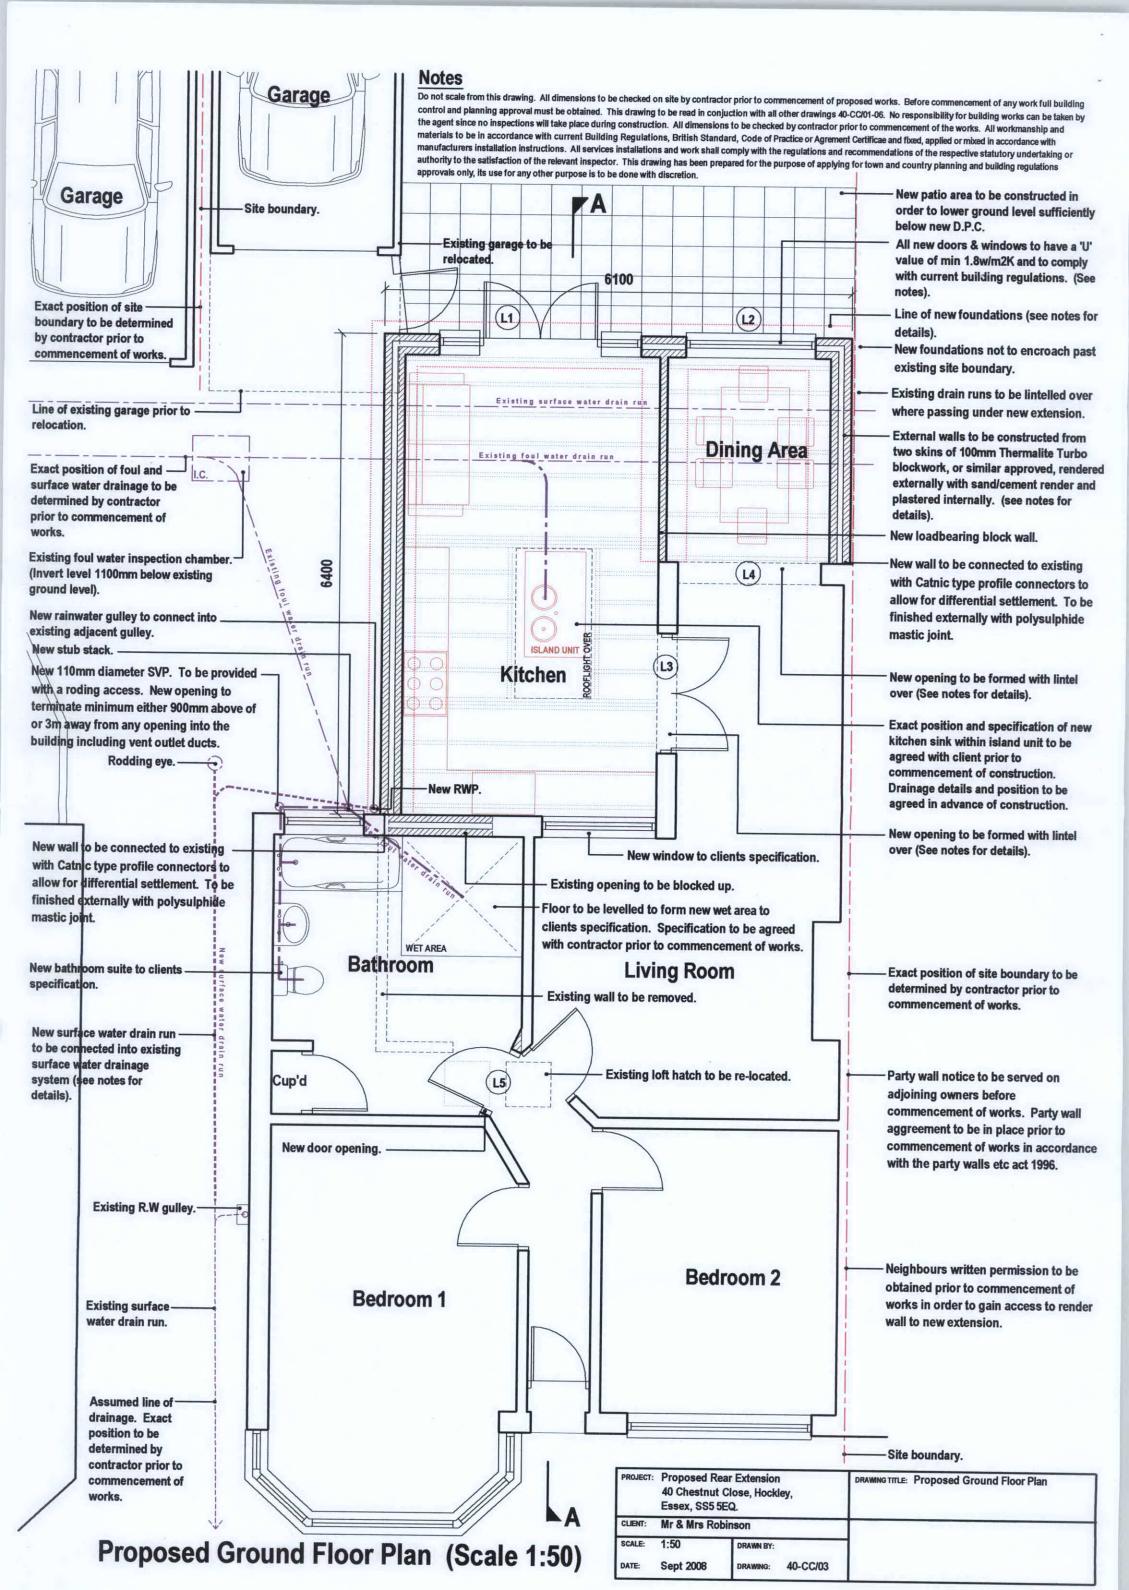

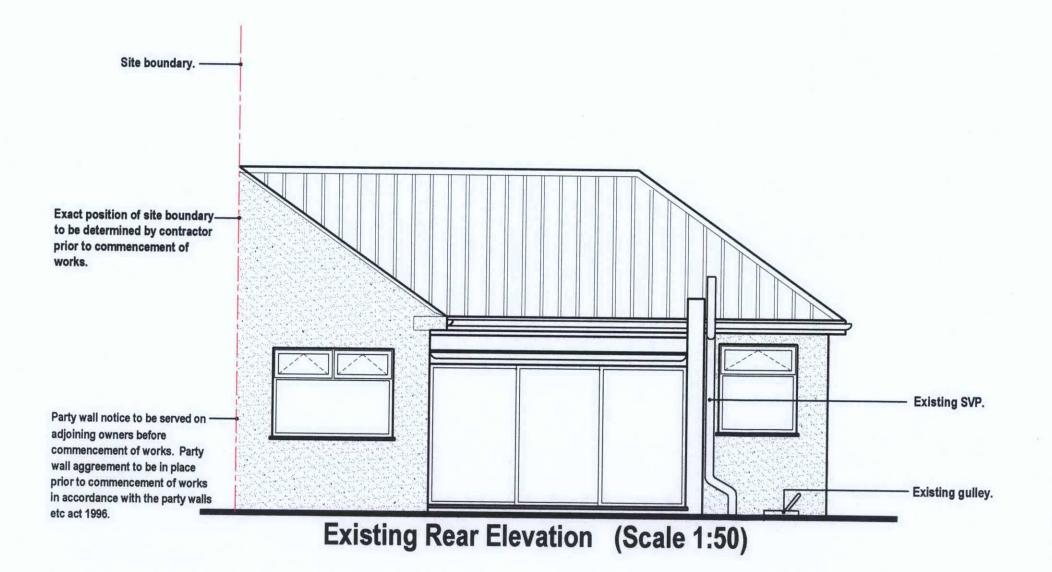

General

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Glazing

Glazing to critical areas as defined in the building regulations part N to comply to BS6206:1981 specification for impact performance requirements for flat safety glass and safety plastics for use in buildings. (6mm Safety glass. See notes). Glazing to all external windows to comprise double glazed units. Window frames to meet the requirements of U2.0. and to be supplied by an approved manufacturer. All window and door frames to to have minimum 16mm gap between frames to achieve a minimum U Value of 1.8W/m2K.

Power and Lighting

Installation to comply with the 'Regulation For Electrical Installations' 17th edition and the latest amendment published by the Institute of Electrical Engineers, and the requirements of the local electricity company. All switches, sockets and other controls are to be sited within a zone of 450-1200mm from F.F.L. New electrical installation to comply fully with Part P regulations and to be tested to BS7671 by an approved inspector upon completion. All electrical work to be designed and carried out by a competent person being a member of an approved self-certification scheme, or wiring diagrams/plans and full design specifications for the proposed electrical installation to be provided. A copy of the installation and test certificate to be submitted to Building Control, signed by a suitably qualified electrician, or to be otherwise compliant. New extension to have a minimum of 25% energy efficiency light fittings.

Rainwater Goods

100mm H.R upvc gutter, with brackets at 1 meter centres fixed with 2No 25x25mm sheridised/zinc plated round head screws, laid to fall to 3mm RWDP.

Part Walls Etc Act 1996

Party wall notice to be served on adjoining owners before commencement of works.

Party wall aggreement to be in place prior to commencement of works in accordance with the party walls etc act 1996.

Mechanical Ventilation

Xpelair at high level to bathroom connected to light switch extracting 15l/s. Kitchen to be fitted with cooker hood capable of extracting 30l/s. All fans to terminate at an external wall or soffit and ducts within roof spaces to be kept below insulation to prevent condensation forming. Ducts to be in a solid material with a nominal fall to the outlet. Bathroom, extract fans to be fitted with a 15minute overrun.

PROJECT:	40 Chestnut Close, Hockley, Essex, SS5 5EQ.		DRAWING TITLE: Existing Rear Elevation	
CLIENT:				
SCALE: DATE:	1:50 Sept 2008	DRAWN BY: DRAWING: 40-CC/04		

General

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Timber (Generally)

All timber which is not naturally durable and resistant to insect attack (See NHBC Schedule Section 2.3) is to be treated with preservative in accordance with said section. All structural timber to be stress graded to BS 4978 and marked 'Dry' or 'Kiln Dried'. Notching and drilling - of timber joists should be carried out in accordance with NHBC standards chapter 6.4. No holes to be formed in steelwork without approval of structural engineer.

determined by contractor prior to

starters of appropriate size to suit

prior to commencement of works.

the party walls etc act 1996.

commencement of works.

Fenestration

Windows/doors - Double glazed, draught proof windows (To clients specification). All windows to be fitted with 8000mm2 trickle ventilation system, opening casements to be minimum 1/20th enclosed room area. Window boards to be bullnose 20mm thick.

Flashing

Wall/roof - Turn roofing material minimum 150mm up wall with tilting fillet. Dress code 4 lead flashing into existing wall and turn into brick/block joint under cavity tray (if appropriate) with lead wedge fixings at 450mm centres. Lead to lap over roofing felt minimum 150mm.

DPC

Marley Aquaguard on mortar bed minimum 150mm above outside ground level, all in accordance with BS5628 Part 1 1985, FL/FN grade or class 4 engineering brickwork ar approved foundation brickwork, i.e. trenchblock below D.P.C. in 1:05:4 cement/lime/sand mortar. Cavity to be filled with learn mix concrete to 150mm below D.P.C and weep holes at 800mm centres at ground floor level to be provided. Wall Plate Restraint

Wall plate to be 75x100mm C24 grade timber on bed of mortar fixed to blockwork with 38x1000mm galvanised steel straps at maximum 1200mm centres. To be fixed using 3.35mm diameter x 75mm corrosion resistant nails.

Lintels

Lintel references relate to ground floor plan on drawing 10-VG/03. All lintels to be as Caradon Catnic Limited.

- L1 CG70/100 Catnic Cougar lintel. L2 CG70/100 Catnic Cougar lintel.

L3 - CTR Catnic extra heavy duty lintel. Site boundary. L4 - CTR Catnic extra heavy duty lintel. L5 - CN102 Catnic Internal partition lintel. Glazed rooflight with white aluminium frame. Rooflight Exact position of site boundary to be to have a 'U' value of min 1.8w/m2K and to comply with current building regulations. (See notes). For details of roof construction see notes. White uPVC fascia and soffit boards to be fitted to new extention. Aluminium trim to be fitted at junction with new roofing felt. Extension to be bonded to existing walls with Catnic stainless steel proprietary wall blockwork and cavity wall construction. Neighbours written permission to be obtained to gain access to render flank wall Party wall notice to be served on adjoining owners before commencement of works. Party wall aggreement to be in place prior to commencement of works in accordance with

Proposed Rear Elevation (Scale 1:50)

New rainwater downpipe.

Flat Roof

bitumen.

Roof preparation - Install treated timber firings (minimum depth 50mm) to create required

falls. Install exterior WBP plywood, ensuring it is of adequate ridgitity to the joist spans

involved. Raise all upstand curb details to provide a minimum 150mm upstand from the

finished roof level. Raise water checks to maintain 50mm upstand from the finished roof

perimeters. Cut new 25mm deep chases in all masonry upstands. These should provide

a minimum 150mm upstand above the finished level of the waterproofing. Install new lead

level. Secure treated timber battens, the equivalent thickness of the insulation, at roof

or metal cover flashings dressed in the chases provided. These should be temporarily

Remove all superflous materials, dust and debris from the roof and leave in a clean and

Vapor control layer laid on plywood comprising: Type 3G venting layer, Type 3mm SBS

Betaelast membrane elestometric underlay bonded. Roof Insulation comprising: 120mm

thick Kingspan TR21 insulation (or similar approved. Fully bonded to the vapour control

layer To achieve a minimum nominal 'U' value of 0.25W/m2K. Partial bond venting layer -

loose laid to top of insulation. Underlay - Betaelast type 3mm SBS underlay. Cap Sheet -

Betaelast 4.5mm mineral sbs cap sheet. All layers by Italiana Membrane Limited. To be

finished with 12.5mm depth of mineral chippings unless a fire designation not less than

AA, AB or AC can be confirmed by the relevant British Standard.

dry condition. Tape all joints with approved taping strip loose laid and mop over with hot

secured with lead or metal wedges and then pointed with a suitable mastic or mortar.

New SVP.

Marley rainwater gutters and downpipes.


New external walls to be constructed from two skins of blockwork and finished externally with 16mm two coat cement/lime/sand render to BS5262 and internally with 13mm plaster with 3mm skim coat. All cavity closers to be of a proprietary type and to be fully insulated

Movement joints to be provided to all brickwork/blockwork walls. Maximum 3m from corners and maximum 6m on straight wall sections.

All new doors & windows to have a 'U' value of min 1.8w/m2K and to comply with current building regulations. (See notes). Line of new DPC.

All brickwork below D.P.C to consist of semi engineering brickwork. Cavity below D.P.C. to be filled with lean mix cement.

PROJECT:	40 Chestnut Close, Hockley, Essex, SS5 5EQ.		DRAWING TITLE: Proposed Front Elevation	
CLIENT:				
SCALE: DATE:	1:50 Sept 2008	DRAWN BY: DRAWING: 40-CC/05		

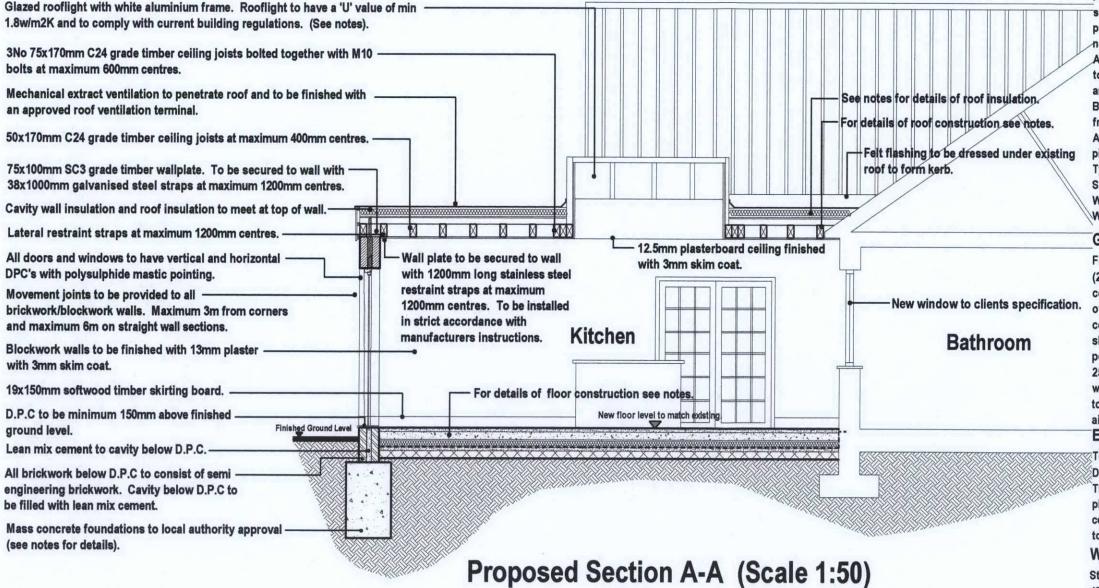

Heating

Existing heating system to be extended to incorporate new areas. Bolier to be checked for suitability to supply increased number of radiators. Heating system to be checked by a CORGI registered installer for suitability prior to commencement of works. Heating system to comply with BS 5440:Part 2:1989. All new radiators to be fitted with TRV's.

Foundations

C15P concrete mix taken minimum 1.1 meters below outside ground level or to invert of any drain whichever deeper, minimum 600mm wide (see foundation plan). Design based on the following: No trees present within proximity of line of new foundations. (See proposed site location plan). Foundations designed in accordance with NHBC standards chapter 4.2. If after investigation assumptions are found to be incorrect the foundations must be redesigned by an engineer to LA approval. Depths to be agreed on site with B.C.O. prior to concreteing.

Drainage

Line of all existing drains to be located at commencement of works.

Provide new back inlet gully taking surface water from new roofs, connect new surface water gulley to surface water drain if available or subject to perculation test provide 1x1x1m soakaway minimum 6m from proposed works. Otherwise connect new surface water drain to existing combined drainage system.

All new drainage to be laid to 1:40 fall. Where drains pass through foundations, pipe to be lintelled over with pre-cast concrete lintels. Pipe to have 50mm space all round and masked both sides. All new below ground drainage to be PVCu 110mm to BS4660, surrounded in 100mm thick pea shingle and backfilled with selected fill, free from stones greater than 40mm dia, clay, timber, frozen or vegetation.

All new gulleys to be of a roddable type. All R.W system to be to BS4756. Minimum pipe/trap and seals to be as follows:

Type	Pipe Size	Trap Size
Sink	50/32mm	75mm
WC	100/75mm	50mm
WHB	50/32mm	75mm

Ground Floor to Extension

Floor construction to consist of 50mm 1:4 mix sand/cement bonded screed min. (25mm cover to service pipes) reinforced with light wire mesh. 100mm thick C30 concrete (20mm max aggregate complying with sections 3.3 of BS8110 part 1) oversite reinforced throughout with BS142 mesh, 450mm min. laps, 25mm min. top cover, 40mm min. bottom cover, with 10mm flexcell movement joint to perimeter of slab. 100mm Jablite SD grade insulation on 1200 gauge visqueen standard polythene DPM lapped to DPC on 100mm sand blinded broken brick hardcore. 25mm upstand of insulation to be provided around perimeter of floors, including where floor slab touches outside wall, including thrsholds. Any existing airbricks to be ducted through oversite with 2No 75mm dia. uPVC pipes to 225x75mm airbricks. All vegetable soil removed under floor.

External Walls

To consist of two skins of 100mm blockwork, 75mm full fill cavity comprising 75mm Dritherm 32 insulation or similar approved, Blockwork skins constructed from Thermalite Turbo blockwork or similar Approved, finished internally with 13mm plaster with 3mm skim coat. Externally finished with pebbledash on 16mm two coat cement/lime/sand render to BS5262. All cavity closers to be of a proprietary type and to be fully insulated

Wall Ties

Stainless steel wall ties to suit cavity width at 750mm max centres horizontally and 450mm max centres vertically and staggered. Provide additional ties at angles and door and window openings.

PROJECT:	Proposed Rear Extension 40 Chestnut Close, Hockley, Essex, SS5 5EQ.		DRAWING TITLE: Proposed Section A-A
CLIENT:	Mr & Mrs Robinson		
SCALE: DATE:	1:50 Sept 2008	DRAWN BY: DRAWING: 40-CC/06	