

Council Offices, South Street
Rochford Essex SS4 1BW
http://www.rochford.gov.uk
planning.applications@rochford.gov.uk / 01702 318191

Application for approval of details reserved by condition.

Town and Country Planning Act 1990

Planning (Listed Buildings and Conservation Areas) Act 1990

ublication of applications on planning authority websites.

lease note that the information provided on this application form and in supporting documents may be published on the Authority's website. you require any further clarification, please contact the Authority's planning department.

1. Applicant N	Name, Address an	d Contact Detail	s				
Title: Mr	First name:	Madison		Surname: F	lomes		
Company name				]			•
Street address:	7 Sackville ROad			]	Country Code	National Number	Extension Number
				Telephone number:			
				Mobile number:		7	
Town/City	Southend-on-Sea					→	
County:	Essex			Fax number:	L		
Country:				Email address:			•
Postcode:	SS2 4UQ						
	ne, Address and Co						
Title: Mr	First Name:	Danny		Surname: K	nott		
Company name:	DK Building Designs	s Ltd		] .			
Street address:	22 Hullbridge Road			]	Country Code	National Number	Extension Number
				Telephone number:		01268 655700	
				Mobile number:			
Town/City	Rayleigh			Fax number:			
County:	Essex						
Country:	United Kingdom			Email address:			
Postcode:	SS6 9NZ			dkbd@btconnect.cor	'n	- <del></del>	

Full postal addres	ss of the site (including	ng full postcode wher	re available)	Description:	<u> </u>
House:	56	Suffix:			
House name:					
Street address:	Highams Road				
Town/City:	Hockley				
County:	Essex				
Postcode:	SS5 4DF				
	cation or a grid refere ted if postcode is no				
Easting:	584716				
Northing:	192557				
Has assistance or Description	prior advice been so	ought from the local a	uthority about this appli	cation? C Yes	<b>(€</b> No
<del></del>	······································	· · · · · · · · · · · · · · · · · · ·	as shown on the decisio	n letter:	
	dwelling and consti				
Application refere		12/00569			Date of decision: 28/11/2012
Please state the condition number		to which this applicati	ion relates:		
2,3,4,6,7,10	1(3).				
Has the developn	nent already started?	? <b>(</b> Yes	No If Yes, plea	ase state when the development was sta	arted: 12/03/2013
Has the developn	nent been completed	d? C Yes	<b>(€</b> No		
5. Discharge o	of Condition(s)				<u> </u>
Please provide a f	full description and/c	or list of the materials/	/details that are being su	bmitted for approval:	
roof tiles - Sandto	oft smooth black				
Brick cream anda	nte buff				
7. Part Discha	rge of Conditio	n(s)			
Are you seeking t	o discharge only par	t of a condition?	C Yes	No	
I. Site Visit					
Can the site be se	en from a public roa	d, public footpath, bri	idleway or other public la	and? <b>(</b> Yes <b>(</b>	No
If the planning au	ithority needs to ma	ke an appointment to	carry out a site visit, who	om should they contact? (Please select o	only one)
<b>C</b> The agent	<b>(</b> The appl	icant C Other	person		
9. Declaration	n				
additional informa	ation. I/we confirm th		our knowledge, any fact	e accompanying plans/drawings and s stated are true and accurate and any	Date 11/04/2013

3. Site Address Details




Suite 5, Daillers House Banters Lane Business Park GREAT LEIGHS CM3 10X

Tel: 01245 363553 Fax: 01245 363580

Email: ssec@btconnect.com

Contract	Part of Structure	Sheet No.	SK/1
56 Highams Road Hockley	Site Investigation	Job No.	8058
Essex SS5 4DF		Date	February 2013

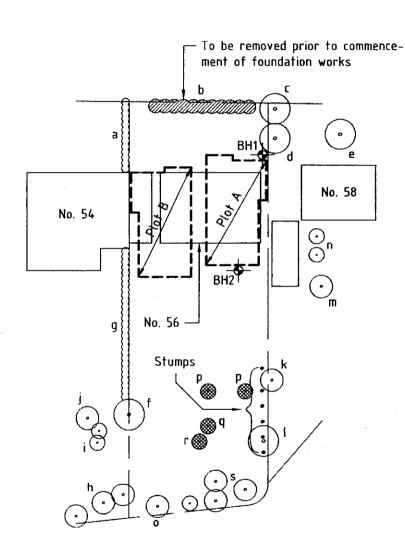

#### Tree Identification:

- a. Privet hedge (2.5m)
- b. Conifers/shrubs (2m)
- c. Conifer (6m)
- d. Hawthorn (8m)
- e. Silver Birch (6m)
- f. Oak (8m)
- g. Privet hedge (2.5-3m)
- h. Conifers (8m)
- i. Cedars (15m)
- i. Silver Birch (8m)
- k. Plum/Wild Cherry (6m)
- I. Crowned Weeping Willow (4m)
- m. Fruit (3m)
- n. Fruits (4m)
- o. Crowned Weeping Willow (5m)
- p. Plum (removed prior to investiga
- q. Horse Chestnut (removed prior
- r. Apple (removed prior to investig
- s. Mixture of Weeping Willow,

Conifer, Elderberry, Yew, Holly

# Site Plan

Scale 1:500

See separate sheets for borehole logs

#### FACTUAL REPORT

## TRIAL PIT & BOREHOLE

#### INVESTIGATION

AT

56 Highams Road, hockley

ON

25<sup>th</sup> January 2013

FOR

Springfield Structural Engineering Consultants

YOUR REF

OUR REF

BAT1072

---- BY ----

B. A. Turner Subsidence Investigation

Whilst reading this report please note:

It is possible that other conditions exist elsewhere on this site, not revealed by the Boreholes or Trial Pits and thus will not have been taken into account

Any reference to ground water relates specifically to the time of the investigation and does not account for any variations due to seasonal or other effects

### B.A. Turner Subsidence Investigation

#### Forge Cottage, 37 Main Road Little Leighs, Chelmsford, Essex, CM3 1NB Email: baturnersiteinvestigation@yahoo.co.uk

Tel/Fax: (01245) 364030 Mobile (07768) 073119

Ref.	BAT1072 B H No. One		43) 3040. Sheet No		viie (07/00) 0731	Date: 25th January 20	13	
Depth Mtrs.	Description of Strata	Thick- ness	Legend	Sample	Test Type Result	Root Information	Depth To Water	D
0.3 0.5	Topsoily, clay Pea shingle  Firm, mid brown/orange, silty, clay, thinly laminated with orange and brown silt and fine sand	300 200 1.300		•	V 60 68	01.m Roots of live appearance to 2mmØ to 0.7m  0.7m Roots of live appearance to 1mmØ		
2.0	Stiff, as above	1.000		•	V 90 96	to 1.2m  1.2m Hair and fibrous roots to 1.7m		
3.0	Stiff, mid brown, silty, clay with parings of orange and brown silt and fine sand	1.000		•	V 110 114			
4.0			A CONTRACTOR OF THE CONTRACTOR	•	V 140+			
	Very stiff, mid brown, silty, clay thinly laminated with orange and brown silt and fine sand	2.000		•	V 140+			
6.0	Very stiff, dark brown, silty, clay thickly laminated with brown silt and fine sand	1.000		•	V 140+			
7.0	·				V 140+			
					V 140+		The state of the s	
!	Very stiff, mid grey, silty, clay with partings of brown and grey silt and	5.000			V 140+			1
	fine sand				V 140+			1
					V 140+			1
12.0	Borehole ends at 12.0m				V 140+			1

Remarks: Borehole dry and open on completion

## B.A. Turner Subsidence Investigation

#### Forge Cottage, 37 Main Road Little Leighs, Chelmsford, Essex, CM3 1NB Email: baturnersiteinvestigation@yahoo.co.uk

Tel/Fax: (01245) 364030 Mobile (07768) 073119

Ref.	BAT1072	B H No. Two		Sheet No	. 1 of 1			Date: 25th January 20	
Depth Mtrs.	Description of Strata		Thick- ness	Legend	Sample	Туре	Test Result	Root Information	Depth To Water
	Topsoily, clay		500					0.1M Roots of live appearance to 3mmØ to 0.4m	
0.5	Firm, mid brown veined, silty, clay orange and brow	with partings of	1.000			V 40		0.4m Roots of live appearance to 1mmØ to 0.8m  0.8m Hair and fibrous roots to 1.4m	
	sand					42			
1.5	Firm, mid brown clay with parting brown silt and fir		500		•	V 70 70			
2.0		grey veined, silty, ated with orange nd fine sand	500		•	V 76 78			
2.5	Stiff, mid brown, clay with parting brown silt and fir		500	and with the circular and a second a second and a second	•	V 90 92			12211
3.0	Borehole ends a	t 3.0m			•	V 108			

Remarks: Borehole wet and open on completion Water seepage at 2.3m. water standing at 2.7m on completion

1 4 FEB 2013



Job Number : CGL03189

Client: Springfields

Client Reference: 8058

Site Name: 56 Highams Road

Date Received: 04/02/2013 Date Testing Started: 04/02/2013 Date Testing Completed: 08/02/2013

Laboratory Used: Chelmer Geotechnical, CM3 8AB

Site	Site Name : 56 Highams Road															Sulphate Content				
42 - 21 - 23	Sample Ref			Moisture Content	Soil Faction > 0.425mm	Liquid Limit	Plastic Limit	Plasticity Index (%) [5]	Liquidity Index (%) [5]	Modified Plasticity Index (%) [6]	Soil Class	Filter Paper Contact Time (h) [8]	Soil Sample Suction (kPa)	Insitu Shear Vane Strength (kPa)   9 ]	Organic Content (%) [ 10 ]	pH Value	50 <sub>3</sub> [ 12 ]	so.	Class [14]	
вн/тр/ws	Depth	UID	Sample Type	(%)[1]	(%)[2]	(%)13)	[%] 4 [			00	СН					6.1	< 0.01	< 0.01	DS-1	
BH1	1.0	37500	D	34	7	58	28	30	0.19	28								***		
BH1	1.5	37501	D	35	8	55	29	25	0.21	23	CH_									
BH1	2.0	37502	D	28	<5	65	27	38	0.04	38	СН									
BH1	2.5	37503	D	28	<5															
BH1	3.0	37504	D	30	<5															
BH1	4.0	37505	D	30	<5			<u> </u>							<u> </u>					
							ļ		<u> </u>			<del> </del>								
																	1		1	
										1							1	<del>                                     </del>	1	
50 to 10 May														+	-				1	
	<del>                                     </del>																+		-	
	-															<u> </u>		-	+-	
	-	-																		

[1] BS 1377 : Part 2 : 1990, Test No 3.2

[7] BS 5930 : 1981 : Figure 31 - Plasticity Chart for the classification of fine soils

[2] Estimated if <5%, otherwise measured

[8] In-house method S9a adapted from BRE IP 4/93

[3] BS 1377 : Part 2 : 1990, Test No 4.4

[9] Values of shear strength were determined in situ by Chelmer Site Investigations using a Pilcon hand vane or Geonor vane (GV).

[4] BS 1377 : Part 2 : 1990, Test No 5.3 [5] BS 1377 : Part 2 : 1990, Test No 5.4

[10] BS 1377 : Part 3 : 1990, Test No 4

[6] BRE Digest 240 : 1993

[11] BS 1377 : Part 2 : 1990, Tast No 9

[12] BS 1377 : Part 3 : 1990, Test No 5.6

[13] SO<sub>4</sub> = 1.2 x SO<sub>3</sub>

[14] BRE Special Digest One (Concrete in Aggressive Ground) 2005

Note that if the SO<sub>4</sub> content falls into the DS-4 or DS-5 class, it would be prudent to consider the sample as falling into the DS-4m or DS-5m class respectively unless water soluble magnesium testing is undertaken to prove otherwise

Key Disturbed sample Bulk sample

U100 (undisturbed sample)

Water sample

Essentially Non-Plastic ENP Underside Foundation

Comments :-

Date Checked :- 08-Feb-13

BS 1377 : 1990

Job Number : CGL03189

Client : Springfields

Client Reference: 8058

Site Name: 56 Highams Road

Applement Septechnical Haboratories

Date Received: 04/02/2013 Date Testing Started: 04/02/2013

Date Testing Started: 04/02/2013

Date Testing Completed: 08/02/2013

Laboratory Used: Chelmer Geotechnical, CM3 8AB

	ample Re	1	60	Moisture	Soil Faction					Modified		Filter Paper		Insitu Shear	Ozzania		Su	lphate Cont	tent
внлтрлуѕ	Depth	UID	Sample Type	Content (%)[1]	> 0.425mm (%) [ 2 ]	Liquid Limit (%) [ 3 ]	Plastic Limit (%) [4]	Plasticity Index (%) [5]	Liquidity Index (%) [5]		Soil Class	Contact Time	Soil Sample Suction (kPa)		Organic Content (%)   10	pH Value {11}	SO <sub>3</sub> [12]	SO₄ [13]	Class (14)
BH2	1.0	37506	D	36	7	57	28	29	0.26	27	СН								
BH2	1.5	37507	D	32	8	56	29	27	0.11	25	СН						-		
BH2	2.0	37508	D	30	<5	59	28	32	0.07	32	СН								
ВН2	2.5	37509	D	26	<5														
вн2	3.0	37510	D	36	<5														
											V V V ********************************								
									9										
	````										·····				*****				
								, , , , , ,											
								140											

Notes :-Key [7] BS 5930 : 1981 : Figure 31 - Plasticity Chart for the classification of fine soils (12) BS 1377 : Part 3 : 1990, Test No 5.6 [1] BS 1377 : Part 2 : 1990, Test No 3.2 D Disturbed sample [2] Estimated if <5%, otherwise measured [8] In-house method S9a adapted from BRE IP 4/93 [13]  $SO_4 = 1.2 \times SO_3$ Bulk sample [3] 8S 1377 : Part 2 : 1990, Test No 4.4 [9] Values of shear strength were determined in situ by Chelmer Site Investigations using a [14] BRE Special Digest One (Concrete in Aggressive Ground) 2005 U100 (undisturbed sample) Pilcon hand vane or Geonor vane (GV). Note that if the SO<sub>4</sub> content falls into the DS-4 or DS-5 class, it would be [4] BS 1377 : Part 2 : 1990, Test No 5.3 Water sample prudent to consider the sample as falling into the DS-4m or DS-5m class (5) 8S 1377 : Part 2 : 1990, Test No 5.4 [10] BS 1377 : Part 3 : 1990, Test No 4 respectively unless water soluble magnesium testing is undertaken to prove Essentially Non-Plastic otherwise (6) BRE Digest 240: 1993 [11] BS 1377 : Part 2 : 1990, Test No 9 Underside Foundation

Comments :-

Produced: - GW Checked By; - MCE Date Checked: - 08-Feb:13

Chelmer Site Investigations 2012

Job Number: CGL03189 Client: Springfields

Client Reference: 8058

Site Name: 56 Highams Road

**Redtechnical** Haboratories Date Received: 04/02/2013

Melmer

Date Testing Started: 04/02/2013 Date Testing Completed: 08/02/2013

Laboratory Used: Chelmer Geotechnical, CM3 8AB

	Sample R	ef		Moisture	Soil Faction	***************************************				Modified		Filter Paper		Insitu Shear	0	I	Su	phate Con	lent
вн/тр/м	S Depth	QIU	Sample Type	Content (%) [ 1 ]	> 0.425mm (%) [ 2 ]	Liquid Limit (%) [ 3 ]	Plastic Limit (%) [4]	Plasticity Index (%) [5]	Liquidity Index (%) [5]		Soll Class	Contact Time	Soil Sample Suction (kPa)	Vane Strength	Organic Content (%) [ 10 ]	pH Value	\$0 <sub>3</sub> [12]	SO₄ [13]	Class
вн2	1.0	37506	D	36	7	57	28	29	0.26	27	СН								
вн2	1.5	37507	D	32	8	56	29	27	0.11	25	СН								
BH2	2.0	37508	D	30	<5	59	28	32	0.07	32	СН								
ВН2	2.5	37509	D	26	<b>&lt;</b> 5													~~~	
ВН2	3.0	37510	D	36	<b>&lt;</b> 5								-					······································	
														, , , , , , , , , , , , , , , , , , , ,					
	- 18 y - <del>18 y</del>																		
-				* - 17				h								1			
				8															8

Notes :-

[1] BS 1377 : Part 2 : 1990, Test No 3.2 (2) Estimated if <5%, otherwise measured

[3] BS 1377 : Part 2 : 1990, Test No 4.4

[4] B\$ 1377 : Part 2 : 1990, Test No 5.3

[5] BS 1377 : Part 2 : 1990, Test No 5.4

[7] BS 5930 : 1981 : Figure 31 - Plasticity Chart for the classification of fine soils

[13]  $SO_4 = 1.2 \times SO_3$ 

otherwise

[8] In-house method S9a adapted from BRE IP 4/93

Pilcon hand vane or Geonor vane (GV).

[10] BS 1377 ; Part 3 : 1990, Test No 4

[11] BS 1377 : Part 2 : 1990, Test No 9

[9] Values of shear strength were determined in situ by Chelmer Site Investigations using a

[14] BRE Special Digest One (Concrete in Aggressive Ground) 2005

Note that if the SO, content falls into the DS-4 or DS-5 class, it would be prudent to consider the sample as falling into the DS-4m or DS-5m class respectively unless water soluble magnesium testing is undertaken to prove

[12] BS 1377 : Part 3 : 1990, Test No 5.6

D Disturbed sample

Bulk sample

Key

U100 (undisturbed sample)

Water sample

Essentially Non-Plastic Underside Foundation

Comments :-

[6] BRE Digest 240 : 1993

Produced :- GW

lab-001

Checked By ;- MCE

Chalmer Site Investigations 2012

Date Checked :- 08-Feb-13


Moisture Content/Shear Strength Profile



Seotechnical

Date Testing Started: 04/02/2013 Job Number : CGL03189 Date Testing Completed: 08/02/2013

Client: Springfields Laboratory: Chelmer Geotechnical Laboratories, CM3 8AB

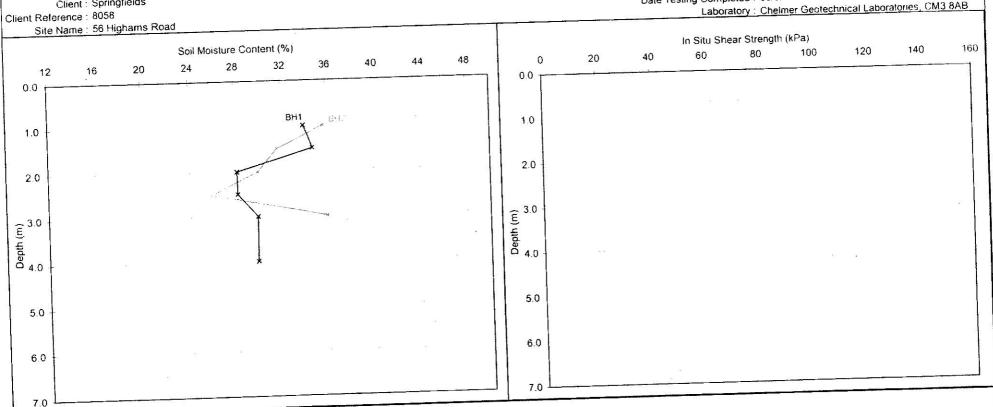

Notes .-

1 If the Soil Fraction > 0.425mm exceeds 5% the Equivalent Moisture Content of the remainder ( calculated in accordance with BS 1377; Part 2 : 1990, cl.3.2.4 note 1 ) is also plotted and the alternative profile additionally shown as an appropriately coloured broken line.

2. If plotted, 0.4 LL and PL+2 ( after Driscoll, 1983 ) should only be applied to London Clay ( and similarly overconsolidated clays ) at shallow depths

Comments :-

Date Checked - 08-Feb-13 Checked By :- GW

Unless otherwise stated, values of Shear Strength were determined in situ by Chelmer Site Investigations using a Pilcon Hand Vane the calibration of which is limited to a maximum reading of 140 kPa.

### Chelmer Geotechnical Laboratories

Unit 15 East Hanningfield Industrial Estate Old Church Road East Hanningfield Essex CM3 8AB Tel: 01245 400930 Fax: 01245 400933 Email: info@soillabs.co.uk


Job No: Client:

Job No: CGL03189

Springfields Ref: 8058 56 Highams Road Received: 04.02.13

Tested: 04.02.13

Complete: 08.02.13

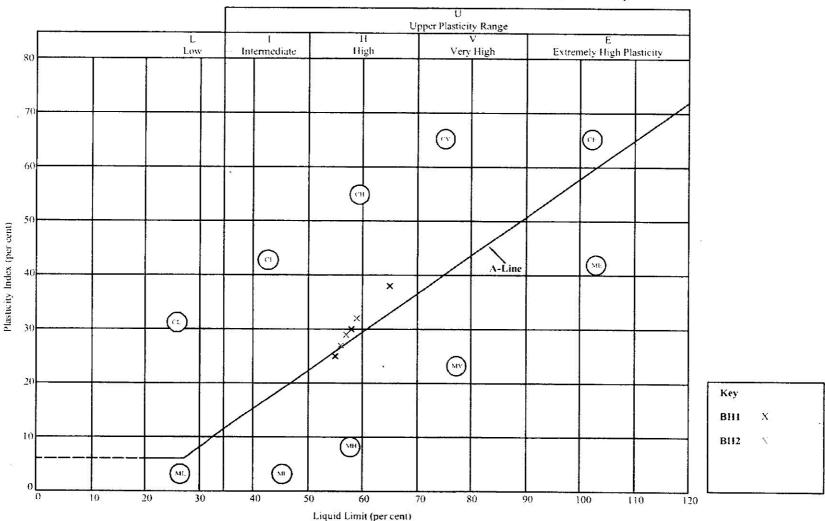

Plasticity Chart for the classification of fine soils and the finer part of coarse soils.

SILT (M-SOIL), M, plots below A-Line CLAY, C, plots above A-Line

M and C may be combined as FINE SOIL, F.

# **DK Building Designs Ltd**


Architectural Designets Planning / Building Consultants

22 Hullbridge Road Rayleigh Essex SS6 9NZ Tel 01268 655700 www.dkbuildingdesigns.co.uk

DRG NO 2607-09


Sheet Size A4

Demolish existing house & replace with two detached houses at 56 Highams Road Hockley

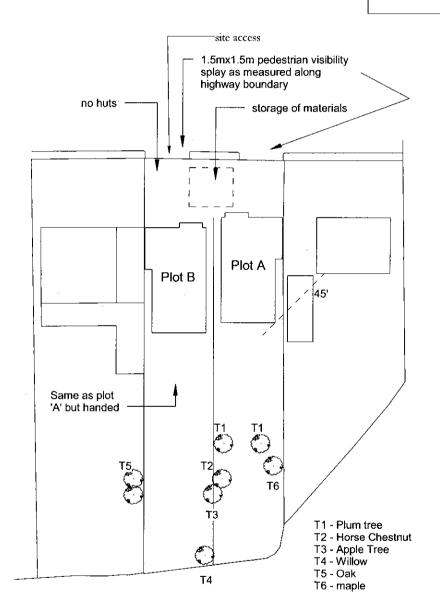

# **Site Plan conditions**

1:500

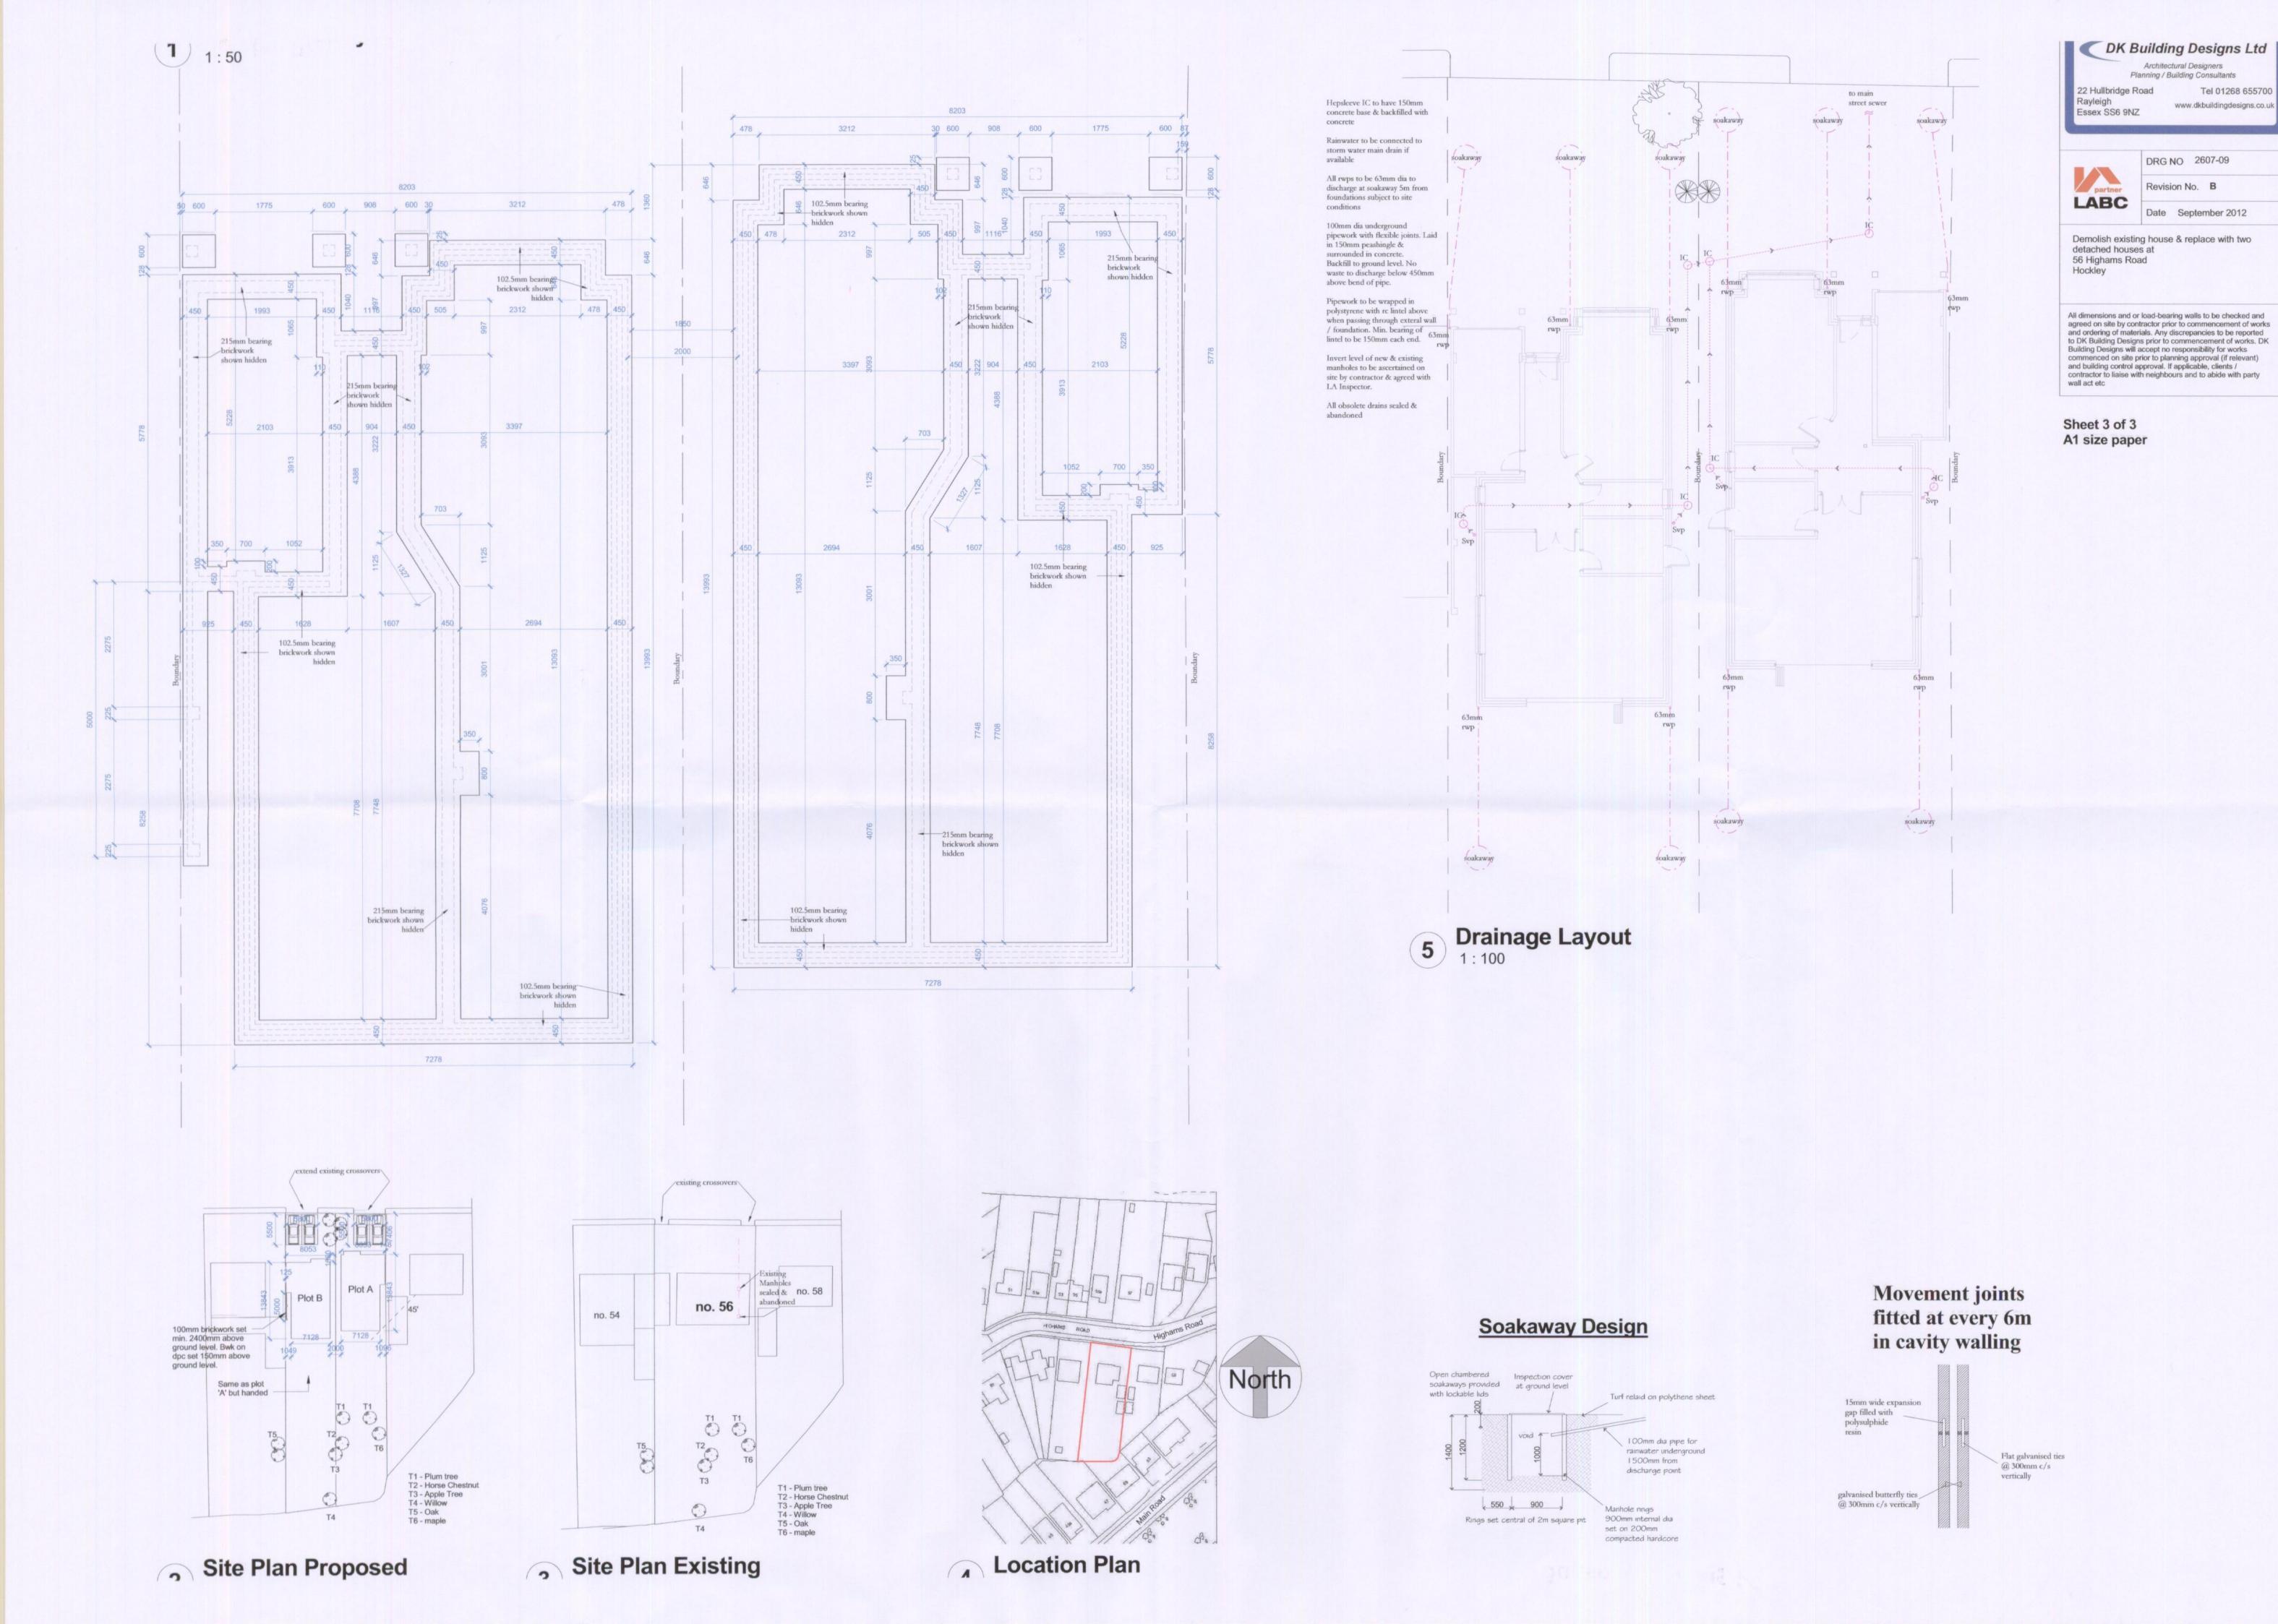

Tel 01268 655700